
Corpus Christi Regional Transportation Authority IFB No. 2017-FC-04 ADA Bus Stop Improvements Phase VI

ZONE 3 CONSTRUCTION DRAWINGS EXHIBIT C-2

Prepared By NEI/HANSON



TXDOT ADA BUS STOP IMPROVEMENTS PHASE VI

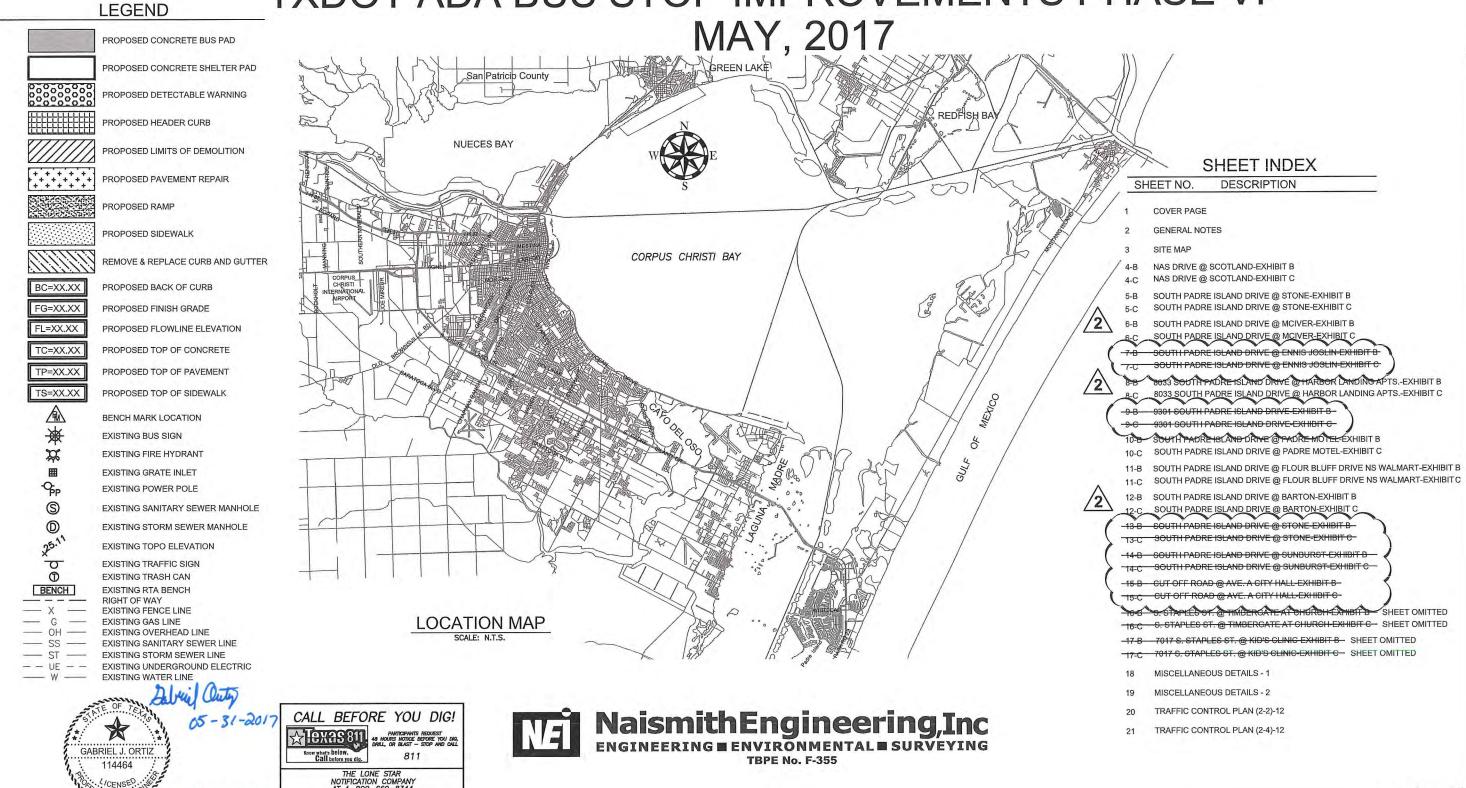

TYFIRM 4417

SHEET 1 OF 21

GENERAL NOTES:

COORDINATION

A. AGENCIES, DEPARTMENTS, AND FIRMS WHO MAY NEED TO BE CONTACTED THROUGHOUT THE DURATION OF THIS PROJECT

REGIONAL TRANSPORTATION AUTHORITY	361-289-2712
CITY OF CORPUS CHRISTI	361-826-3500
CITY OF CORPUS CHRISTI TRAFFIC ENGINEERING	361-826-3500
CITY OF CORPUS CHRISTI MUNICIPAL INFORMATION SYSTEMS	361-826-3766
TEXAS DEPARTMENT OF TRANSPORTATION	361-808-2384
NAISMITH ENGINEERING, INC.	361-814-9900
TEXAS 811	800-344-8377
SOUTHWESTERN BELL LOCATE	800-828-5127
LONE STAR NOTIFICATION	800-669-8344
TEXAS ONE CALL	800-245-4545

- B. LOCATION AND ADJUSTMENT OF CONFLICTING UTILITIES SHALL BE COORDINATED WITH LOCAL UTILITY AFFECTED. SOME PLANS SHOW INFORMATION OBTAINED FROM SURFACE SURVEY WHICH IS INTENDED AS AN AID FOR THE CONTRACTOR IN DETERMINING APPROXIMATE LOCATION OF CERTAIN LINES UNDERGROUND UTILITIES DO NOT APPEAR ON THE PLANS BUT MAY EXIST IN THE AREAS OF PROPOSED IMPROVEMENTS. IT IS THE CONTRACTOR'S RESPONSIBILITY TO LOCATE AND PROTECT ALL WORK WITH AGENCIES IN MAKING ALL ADJUSTMENTS REQUIRED BY THE PROJECT. ADJUSTMENTS SHALL BE PERFORMED BY CONTRACTOR OR AFFECTED UTILITY COMPANY WITH NO SEPARATE PAYMENT FOR THIS
- C. THE CONTRACTOR SHALL NOTIFY THE ENGINEER AND UTILITY COMPANY IF THERE ARE ANY
- D. CONTRACTOR IS RESPONSIBLE FOR OBTAINING ALL APPLICABLE CONSTRUCTION PERMITS AND FOR PAYING ANY ASSOCIATED FEES.
- E. IT SHALL BE THE RESPONSIBILITY OF THE CONTRACTOR TO NOTIFY ALL APPROPRIATE UTILITY COMPANIES, CITY TRAFFIC ENGINEERING, & CITY MIS DEPARTMENT 48 HOURS PRIOR TO ACTUAL CONSTRUCTION FOR THE EXACT LOCATION OF EXISTING UTILITIES. THE CONTRACTOR SHALL NOTIFY PROPERTY OWNERS OF PROPOSED CONSTRUCTION IN FRONT OF THE RESPECTIVE PROPERTIES AT LEAST 48 HOURS PRIOR TO START OF CONSTRUCTION. THIS WORK WILL NOT BE PAID FOR DIRECTLY BUT SHALL BE CONSIDERED SUBSIDIARY TO THE
- F. OSHA REGULATIONS PROHIBIT OPERATIONS THAT WILL BRING PERSONS OR EQUIPMENT WITHIN 10 FEET OF AN ENERGIZED ELECTRICAL LINE. WHERE WORKMEN AND/OR EQUIPMENT HAVE TO WORK CLOSE TO AN ENERGIZED ELECTRICAL LINE, THE CONTRACTOR SHALL NOTIFY THE ENGINEER AND THE ENGINEER WILL COORDINATE WITH THE ELECTRICAL POWER COMPANY TO MAKE WHATEVER ADJUSTMENTS ARE NECESSARY TO ENSURE THE SAFETY OF WORKMEN WORKING NEAR THE ENERGIZED LINE. ERECTION AND/OR REMOVAL OF POLES LOCATED NEAR ANY OVERHEAD ELECTRICAL LINES SHALL BE ACCOMPLISHED USING ESTABLISHED INDUSTRY AND UTILITY SAFETY PRACTICES. THE CONTRACTOR SHALL CONSULT WITH THE APPROPRIATE UTILITY COMPANY PRIOR TO BEGINNING SUCH WORK.

2. TRAFFIC CONTROL

- A. THE CONTRACTOR IS RESPONSIBLE FOR UTILIZING A TRAFFIC CONTROL PLAN THAT HAS BEEN APPROVED BY THE CITY OR STATE PRIOR TO COMMENCING ANY CONSTRUCTION ACTIVITIES. ALL PERMITS AND FEES ASSOCIATED WITH TRAFFIC CONTROL PLAN MUST BE ACQUIRED OR PAID PRIOR TO COMMENCING WORK ALL FEES ARE SUBSIDIARY TO THE COST OF CONSTRUCTION. CONTRACTOR SHALL PROVIDE 48 HOUR ADVANCE NOTICE, PRIOR TO COMMENCING ANY LANE CLOSURES, TO THE CITY OR STATE TO ALLOW FOR PUBLIC NOTIFICATION OF ANTICIPATED CLOSURES.
- B. VEHICULAR TRAFFIC TO ADJACENT PROPERTY, HIGHWAYS, PUBLIC ROADS AND STREET CROSSING MUST BE ACCOMMODATED AT ALL SITES DURING CONSTRUCTION. THE CONTRACTORS PLAN FOR ACCOMMODATING TRAFFIC MUST BE SUBMITTED TO AND APPROVED BY THE ENGINEER PRIOR TO DISTURBING OR DEMOLISHING ANY ROADWAY OR PEDESTRIAN SURFACES WITHIN THE LIMITS OF CONSTRUCTION
- C. ALL WORK IS TO BE COMPLETED BY THE CONTRACTOR DURING DAYLIGHT HOURS. THE CONTRACTOR IS TO PLACE BARRICADES AND BARRELS ADJACENT TO THE WORK SITE. AT THE END OF THE DAY THE CONTRACTOR SHALL OPEN TRAFFIC IF BOTH DIRECTIONS AT ALL INTERSECTIONS. DURING CONSTRUCTION, TRAFFIC CONTROL PLAN TCP (2-2)-12 OR (2-4)-12 FOR DAYTIME OPERATION SHALL BE USED. THE ROADWAY SHALL BE REOPENED TO TRAFFIC AT THE END OF EACH WORKDAY.
- D. BARRICADE AND TRAFFIC CONTROL SHALL COMPLY WITH THE CITY OF CORPUS CHRISTI TRAFFIC ENGINEERING DIVISION "UNIFORM BARRICADING STANDARDS AND PRACTICES", AND THE TEXAS DEPARTMENT OF TRANSPORTATION. BARRICADED WORK AREAS SHALL BE LIMITED TO ONE SIDE OF THE BLOCK, EXTENDING FROM CORNER TO CORNER IN ONE DIRECTION, UNLESS OTHERWISE AUTHORIZED BY THE ENGINEER. THE CONTRACTOR MAY BE REQUIRED TO FURNISH ADDITIONAL BARRICADES AND SIGN TO MAINTAIN TRAFFIC AND MOTORIST SAFETY. ANY SUCH ADDITIONAL SIGNS AND BARRICADES SHALL BE CONSIDERED SUBSIDIARY TO THE PROJECT. CONTRACTOR SHALL NOT DETOUR TRAFFIC INTO OPPOSING TRAVEL LANES. CONTRACTOR SHALL PROVIDE PEDESTRIAN TRAFFIC CONTROL FOR CLOSED SIDEWALK.
- E. THE CONTRACTOR SHALL SUPPLEMENT THE FLAGGER'S LOCATION SHOWN ON THE TRAFFIC CONTROL PLAN SHEETS WITH A TRAILER MOUNTED FLASHING ARROW PANEL.
- F. TRAFFIC CONTROL FOR LANE CLOSURES SHALL BE IN ACCORDANCE WITH THE APPROPRIATE TRAFFIC CONTROL PLAN STANDARD SHEETS.
- G CONTRACTOR MUST MAINTAIN A 10' LANE AT ALL TIMES.

DEMOLITION

- A. ALL CONCRETE AND ASPHALT SHALL BE SAW-CUT TO FULL DEPTH.
- B. PAVEMENT REPAIR SHALL BE A MAXIMUM OF 2' WIDE THE PAVEMENT SHALL BE SAW CUT. THE CONTRACTOR IS RESPONSIBLE FOR PROTECTING THE EDGE OF THE SAW CUT PAVEMENT DURING THE CONSTRUCTION PROCESS. IF THE EDGE IS DAMAGED BY THE CONSTRUCTION ACTIVITY OR TRAFFIC, THEN THE CONTRACTOR IS RESPONSIBLE FOR CUTTING A NEW CLEAN EDGE, EXTRA PAVEMENT REPAIR RESULTING FROM A DAMAGED EDGE WILL BE DONE AT THE CONTRACTORS OWN EXPENSE.
- C. EXISTING UTILITIES SHOWN ON THE PLANS ARE FOR REFERENCE ONLY AND DO NOT NECESSARILY REPRESENT THE EXACT LOCATION OF SUCH FACILITIES, NOR IS IT IMPLIED THAT ALL EXISTING UTILITIES ARE SHOWN ON THE PLANS. NAISMITH ENGINEERING, INC. ASSUMES NO RESPONSIBILITY FOR THE EXISTENCE OR LOCATION OF ANY SUBSURFACE UTILITIES OR STRUCTURES. THE CONTRACTOR IS RESPONSIBLE FOR CONTACTING THE APPROPRIATE UTILITY OWNERS AND LOCATING ALL EXISTING UNDERGROUND AND OVERHEAD UTILITIES PRIOR TO COMMENCING WITH ANY CONSTRUCTION
- D. CONTRACTOR SHALL NOT EXCEED THE LIMITS OF DEMOLITION INDICATED ON THE PLANS. EXCESS DEMOLITION WHICH IS DONE BY THE CONTRACTOR WITHOUT THE ENGINEER'S APPROVAL WILL NOT BE PAID FOR. EXTRA CONSTRUCTION RESULTING FROM EXCESS DEMOLITION WILL NOT BE PAID FOR, THE QUANTITIES INDICATED ON THE PLANS WILL BE UTILIZED FOR PAYMENT OF DEMOLITION.

4. CONSTRUCTION

- A. THE CONTRACTOR SHALL VISIT THE PROJECT SITES TO EXAMINE LOCAL CONDITIONS AND PERFORM ACTIONS NECESSARY TO ASSURE THAT THEY UNDERSTAND THE PROJECT THOROUGHLY AND ARE FULLY AWARE OF ALL CONDITIONS AND CONSTRAINTS WHICH MAY BE ENCOUNTERED DURING THE COURSE OF CONSTRUCTION. THE CONTRACTOR SHALL BE RESPONSIBLE FOR DETERMINING THE LOCATION OF RIGHT-OF-WAY LINES WITH A REGISTERED PROFESSIONAL LAND SURVEYOR AND ALL WORK SHALL BE PERFORMED WITHIN THE RIGHT-OF-WAY. THE CONTRACTOR SHALL IMMEDIATELY NOTIFY THE PROJECT MANAGER IF PROPOSED IMPROVEMENTS ARE DETERMINED TO BE OUTSIDE OF THE RIGHT-OF-WAY.
- B. THE CONTRACTOR IS RESPONSIBLE FOR STAKING OUT AND CONSTRUCTING THE WORK IN ACCORDANCE WITH REQUIREMENTS OF THE PLANS AND SPECIFICATIONS. CONTRACTOR MAY NOT MAKE ADJUSTMENTS WITHOUT PRIOR APPROVAL OF THE ENGINEER.
- C. CONSTRUCTION OF NEW CURB AND GUTTER SHALL MATCH EXISTING ELEVATIONS AT EACH END OF CURB AND GUTTER, AND SHALL BE SLOPED UNIFORMLY TO PREVENT PONDING. CONSTRUCTION OF NEW CONCRETE SHELTER PAD SHALL MATCH EXISTING/PROPOSED TOP OF STREET CURB AND GUTTER ELEVATION AND SHALL BE SLOPED 1.5% MAXIMUM TOWARDS CURB AND GUTTER, UNLESS OTHERWISE NOTED. CONSTRUCTION OF NEW CONCRETE SIDEWALK SHALL MATCH EXISTING/PROPOSED TOP OF STREET CURB AND GUTTER ELEVATION WHEN ABUTTING CURB AND GUTTER. CONSTRUCTION OF NEW CONCRETE SIDEWALK SHALL NOT EXCEED 2% CROSS SLOPE, AND 5% RUNNING SLOPE. PURPOSE OF NEW CONCRETE TRANSITIONS IS TO CONNECT PROPOSED ACCESSIBLE ROUTE IMPROVEMENT ELEVATIONS TO THE EXISTING WALKING SURFACES ELEVATIONS. CONCRETE TRANSITIONS SHALL BE CONSIDERED PROJECT IMPROVEMENTS AND SHALL NOT BE CONSIDERED A COMPONENT OF THE ACCESSIBLE ROUTE.
- D. TOP OF RAMP CURBS (EDGE PROTECTION) ARE INTENDED TO RETAIN NATURAL GROUND AND SHALL MATCH EXIST NATURAL GROUND ELEVATION.
- E. THE CONTRACTOR SHALL BE RESPONSIBLE FOR ADJUSTMENT OF UTILITY BOXES, MANHOLES ETC., TO MATCH PROPOSED GRADES, AND ADJUSTMENT OF STANDARD SIGNAGE OBSTRUCTING ACCESSIBLE ROUTES. ADJUSTMENT OF UTILITIES, IF NEEDED, WILL BE THE CONTRACTORS RESPONSIBILITY, WITH COORDINATION PROVIDED BY THE ENGINEER. CONTRACTOR MAY NOT MAKE ADJUSTMENTS WITHOUT PRIOR APPROVAL OF THE ENGINEER. THE CONTRACTOR SHALL COORDINATE GAS VALVE ADJUSTMENTS WITH THE CITY GAS DEPARTMENT (885-8900)
- THE CONTRACTOR SHALL PLACE CLASS "A"(WATER & GAS) CONCRETE COLLARS AROUND ADJUSTED VALVES (6" MIN. WIDTH) & MANHOLES (12" MIN. WIDTH) AND A MINIMUM 12" DEPTH, ALL AS DIRECTED BY THE ENGINEER.
- G. EXCESS EXCAVATION AND DEMOLISHED MATERIALS WILL BECOME THE PROPERTY OF THE CONTRACTOR AND IS TO BE DISPOSED OF PROPERLY. ANY FILL MATERIAL REQUIRED FOR SUCCESSFUL COMPLETION OF THE PROJECT WILL BE SIMILAR TO THE NATIVE SOILS IN THE AREA IN CLASSIFICATION, GRADATION AND COMPACTION. EXCAVATION AND FILL REQUIRED TO COMPLY WITH SLOPE REQUIREMENTS IS CONSIDERED SUBSIDIARY TO THE PROJECT CONTRACTOR SHALL REPLACE DISTURBED SOD WITH SAME SPECIES. SITE SHALL BE RESTORED TO ITS ORIGINAL CONDITION OR BETTER.
- H. CLEANING OF ASPHALT EQUIPMENT WILL NOT BE ALLOWED AT THE PROJECT SITE OR IN PUBLIC RIGHT OF WAY, ANY PETROLEUM PRODUCTS SPILLED SHALL BE CLEANED UP AND DISPOSED OF PROPERLY. NO CONSTRUCTION WASTE MATERIALS WILL BE ALLOWED TO BE
- I. IF ANY HAZARDOUS MATERIALS AND/OR CONTAMINATED SOILS ARE DISCOVERED DURING CONSTRUCTION, THE CONTRACTOR SHALL NOTIFY THE ENGINEER IMMEDIATELY FOR ASSISTANCE IN IDENTIFYING AND TESTING OF MATERIALS AND SOILS.

- J. FIELD CONDITIONS SOMETIMES DICTATE THAT THE LAYOUT BE ADJUSTED. CONTRACTOR MAY NOT MAKE ADJUSTMENTS WITHOUT PRIOR APPROVAL OF THE ENGINEER.
- K 6" CURB NOT INCLUDED IN RAMP SECTION SHALL BE QUANTIFIED AS 6" HEADER CURB
- L. THE CONTRACTOR SHALL TAKE ALL PRECAUTIONS NECESSARY TO PROTECT ALL EXISTING UTILITIES, PIPES, UNDERGROUND STRUCTURES, TRAFFIC SIGNAL BOXES, ELECTRICAL CONDUIT AND CABLES, BUILDINGS, DRIVEWAYS, FENCES AND ALL OTHER PROPERTIES. ALL DAMAGED PROPERTY SHALL BE RESTORED BY THE CONTRACTOR TO ITS ORIGINAL CONDITION. ACCORDING TO CITY OF CORPUS CHRISTI STANDARDS, OR BETTER AT NO SEPARATE PAY,
- M. ALL EXISTING PAVEMENT WHICH ARE CUT OR DAMAGED BY THE CONTRACTOR IN THE PROCESS OF HIS WORK WILL BE REPLACED AS QUICKLY AS POSSIBLE AND AS DIRECTED BY THE
- N. HMAC PAVEMENT REPAIR SHALL BE COMPACTED AS DIRECTED BY THE INSPECTOR/ENGINEER
- O. FINAL GRADES SHALL BE SLOPED TO PROVIDE POSITIVE DRAINAGE WITH NO PONDING OF WATER. THE CONTRACTOR IS RESPONSIBLE TO MAINTAIN AND NOT BLOCK OR IMPEDED
- P. THE CONTRACTOR SHALL HAVE IN PLACE THE NECESSARY STORM WATER SEDIMENT TRAPS AT CURB INLETS AND OPEN DITCH LINE AREA WHILE PERFORMING WORK AND UNTIL WORK IS COMPLETE IN THAT AREA AND VEGETATION IS ESTABLISHED.
- Q. THE CONTRACTOR WILL BE ALLOWED 14 CALENDAR DAYS TO COMPLETE CONSTRUCTION OF DEMOLISHED AREA. IF CONTRACTOR EXCEEDS 14 CALENDAR DAYS AT ANY SITE, NO NEW DEMOLITION WILL BE ALLOWED. ONCE THE CONTRACTOR HAS COMPLETED PREVIOUSLY DEMOLISHED AREAS. HE MAY RESUME NEW DEMOLITION.

5. COMPLIANCE WITH ADA AND TAS FOR ACCESSIBLE ROUTES

- A. EVERY EFFORT HAS BEEN MADE BY THE ENGINEER TO COMPLY WITH THE AMERICANS WITH DISABILITIES ACT AND TEXAS ACCESSIBILITY STANDARDS. DURING CONSTRUCTION, THE CONTRACTOR IS ULTIMATELY RESPONSIBLE FOR CONSTRUCTING THE IMPROVEMENTS IN ACCORDANCE WITH THE STANDARDS INCLUDED IN THESE DOCUMENTS. CONFLICTS WITH THE PLANS AND/OR SPECIFICATIONS FOUND BY THE CONTRACTOR SHALL BE IMMEDIATELY REPORTED TO THE ENGINEER BEFORE PROCEEDING WITH
- B. THE MINIMUM STANDARDS OUTLINED BELOW SHALL BE ADHERED TO AT ALL TIMES.
 - I ALL SIDEWALKS SHALL BE A MINIMUM OF 4" THICK. SEE DETAIL SHEETS
 - II. THE FOLLOWING GENERAL TEXAS DEPARTMENT OF LICENSING AND REGULATION (TDLR) CRITERIA APPLY TO MANEUVERING SURFACES AT DOORS, ENTRIES, PORCHES, RAMP LANDINGS, PARKING AREAS, WALKWAYS AND PAVEMENT WHICH ARE PART OF A REQUIRED ACCESSIBLE ROUTE FOR ENTRY/EXIT.
 - a. THE REQUIRED CLEAR FLOOR SPACE AREA AT ACCESSIBLE ENTRY/EXIST DOORS SHALL NOT HAVE A SLOPE THAT EXCEEDS 1:50 (2%) IN ANY DIRECTION.
 - b CROSS SLOPE FOR ACCESSIBLE WALKWAYS SHALL NOT EXCEED 1:50 (2%).
 - c. RUNNING SLOPE FOR ACCESSIBLE WALKWAYS SHALL NOT EXCEED 1:20 (5%)
 - d. PAVEMENT SURFACES THAT ARE PART OF A REQUIRED ACCESSIBLE ROUTE SHALL NOT EXCEED 1:50 (2%) CROSS SLOPE AND 1:20 (5%) RUNNING SLOPE.
 - e. CHANGES IN GRADE IN ACCESSIBLE ROUTES GREATER THAN 1:20 (5%) REQUIRE A RAMP.
 - f. ABRUPT CHANGES IN LEVEL IN EXCESS OF $\frac{1}{4}$ " ARE NOT PERMITTED.
 - g. LEVEL LANDINGS SHALL BE SLOPED 2% MAX TOWARDS STREET CURB & GUTTER, NATURAL GROUND ADJACENT TO PROJECT IMPROVEMENTS SHALL BE GRADED TO DRAIN INTO STREET CURB & GUTTER AND AWAY FROM PRIVATE PROPERTY.
 - III. ACCESSIBLE ROUTE ELEVATIONS INDICATED ON THE GRADING PLAN ARE SCHEMATIC, AND ARE INTENDED TO COMPLY IN ALL RESPECTS WITH TDLR REQUIREMENTS. THE CONTRACTOR IS TO ADJUST GRADES AS NECESSARY TO FIT PARTICULAR CONDITIONS. NOTIFY ENGINEER AND REQUEST INSTRUCTION IF NON-COMPLIANT SITUATIONS ARE ENCOUNTERED OR ANTICIPATED.
 - IV. CONCRETE SURFACE ALONG THE ACCESSIBLE PATHWAY SHALL RECEIVE A LIGHT BROOM FINISH UNLESS NOTED OTHERWISE
 - V. THE DETECTABLE WARNING PANELS MUST COMPLY WITH TEXAS ACCESSIBILITY STANDARDS 705 AND ADMINISTRATIVE RULES OF THE TDLR, 16 TAC CHAPTER 68, SECTION 68.102 AT A MINIMUM OF 24 INCHES IN DEPTH (IN THE DIRECTION OF PEDESTRIAN TRAVEL) AND EXTEND THE FULL WIDTH OF THE CURB. DETECTABLE WARNING PANELS MUST BE A TXDOT APPROVED PANEL MATERIAL, BRICK PAVERS OR METAL PANELS WILL NOT BE ALLOWED. THE PANELS SHALL BE RED IN COLOR. DETECTABLE WARNING PANEL MUST FOLLOW THE CURB LINE ON CURB RADII AND MAY BE NO MORE THAN 6 TO 10 INCHES FROM THE PROJECTED FACE OF CURB CURVED PANELS OR CUT PANELS WILL BE REQUIRED.

CONCRETE SHELTER PAD	1732	SF
RAMPS SECTION	0	SF
LANDING SECTION	0	SF
SIDEWALK SECTION	289	SF
CURB AND GUTTER	0	LF
12" HEADER CURB	0	LF
6" HEADER CURB	51	LF
DEMOLITION OF FOUNDATION	3	LF
DEMOLITION OF 6" HEADER CURB	0	LF

PAVEMENT REPAIR	0	SF
DEMOLITION OF EXISTING CURB & GUTTER	0	LF
DEMOLITION OF EXISTING SIDEWALK	1000	SF
DEMOLITION OF EXISTING SHELTER PAD	0	SF
SAW CUT CONCRETE PAVEMENT	58	LF
SAW CUT ASPHALT PAVEMENT	51	LF
RELOCATE EXISTING BUS STOP SIGN	2	EA
TYPE "C" CROSS WALK (12" WIDE)	0	LF
TYPE "C" CROSS WALK (24" WIDE)	0	LF

REVISIONS APPR. DATE OMITTED SHEETS 05/16



OFFICE LOCATION :

4501 Gollibar Rd Corpus Christi, Texas 78411 P.O. Box 3099 Corpus Christi, Texas 78463 (361)-814-9900

Drawn By: Approved By: GO roject No. : 9567 AS SHOWN 05-25-2017





CORPUS CHRISTI REGIONAL TRANSPORTATION AUTHORITY **ADA BUS STOP IMPROVEMENTS PHASE VI OCTOBER 2015 GENERAL NOTES**

REGIONAL TRANSPORTATION AUTHORITY CORPUS CHRISTI, TEXAS


9567-EXHIBIT

Sheet 2 Of 21

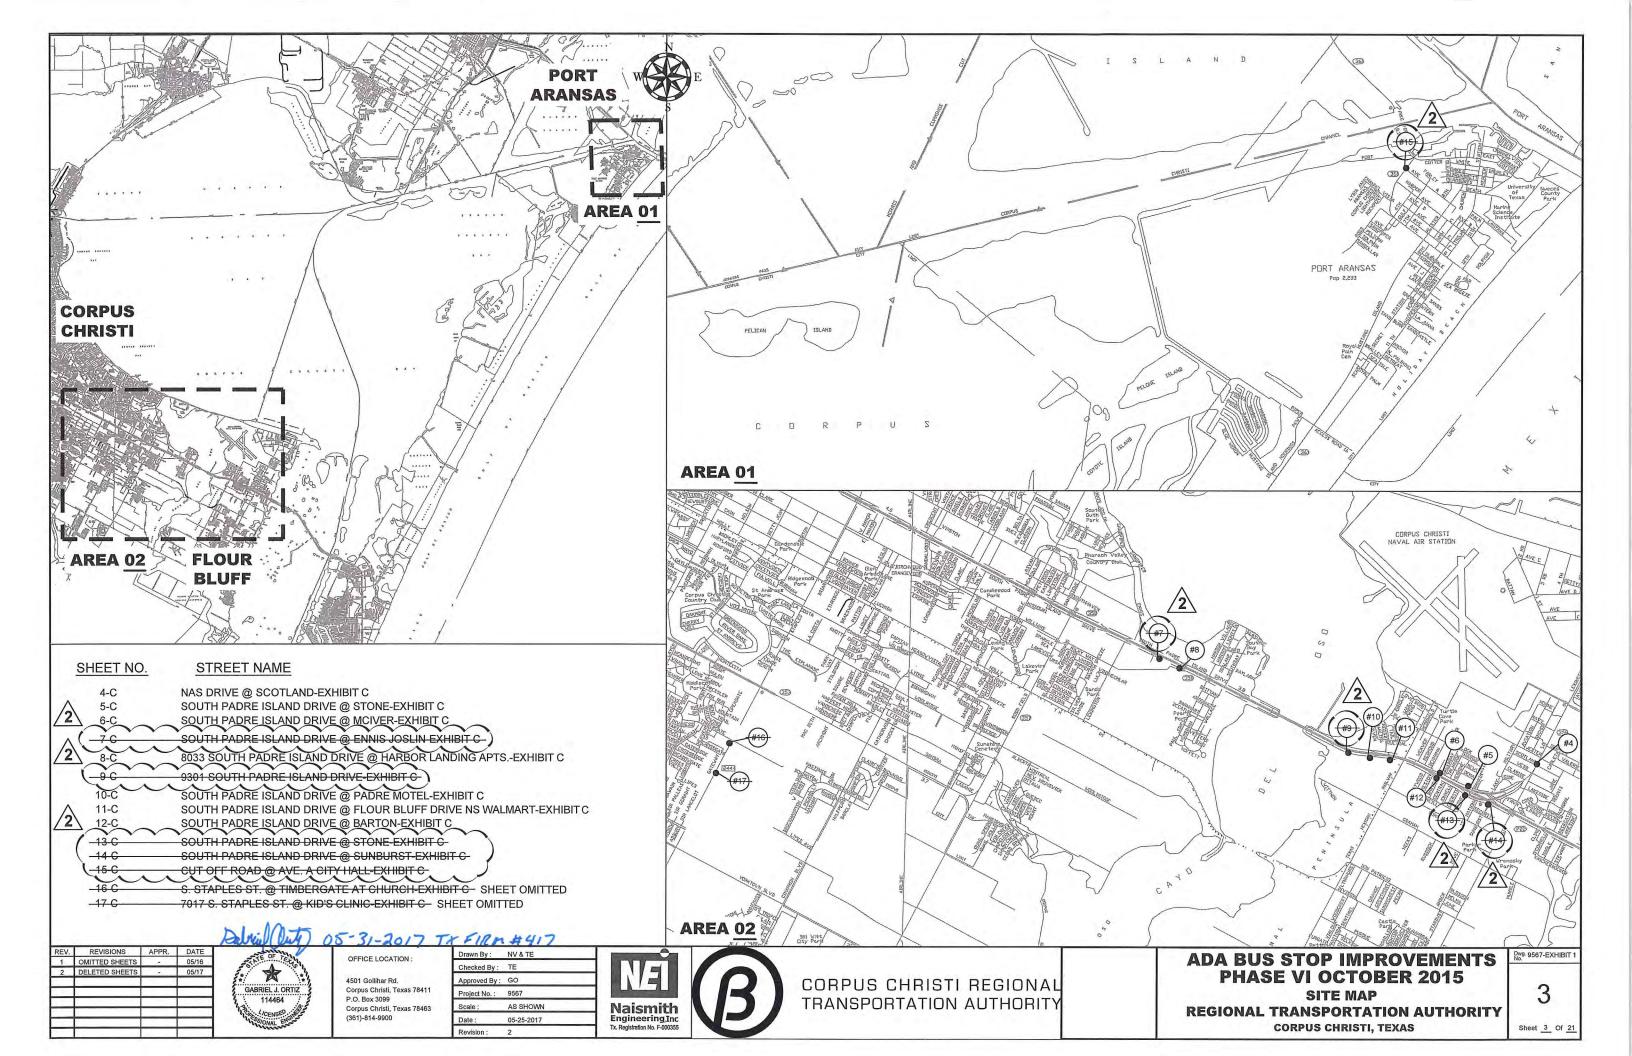

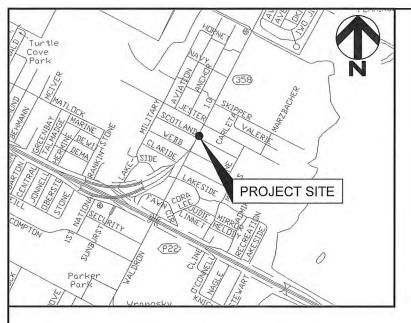

CONCRETE SHELTER PAD	360	SF
CONCRETE BUS PAD	- 4	SF
RAMPS SECTION	-	SF
LANDING SECTION	J (1)	SF
SIDEWALK SECTION	40	SF
CURB AND GUTTER		LF
SIDEWALK DRAIN CROSSING	1	SF
6" HEADER CURB		LF
PAVEMENT REPAIR		SF
DEMOLITION OF EXISTING CURB AND GUTTER		LF
DEMOLITION OF EXISTING SIDEWALK	160	SF
DEMOLITION OF EXISTING SHELTER PAD	- <u>-</u>	SF
SAW CUT CONCRETE PAVEMENT	8	LF
SAW CUT ASPHALT PAVEMENT		LF
RELOCATE EXISTING BUS STOP SIGN	_	EA
TRAFFIC CONTROL PLAN ALLOWANCE	1	LS

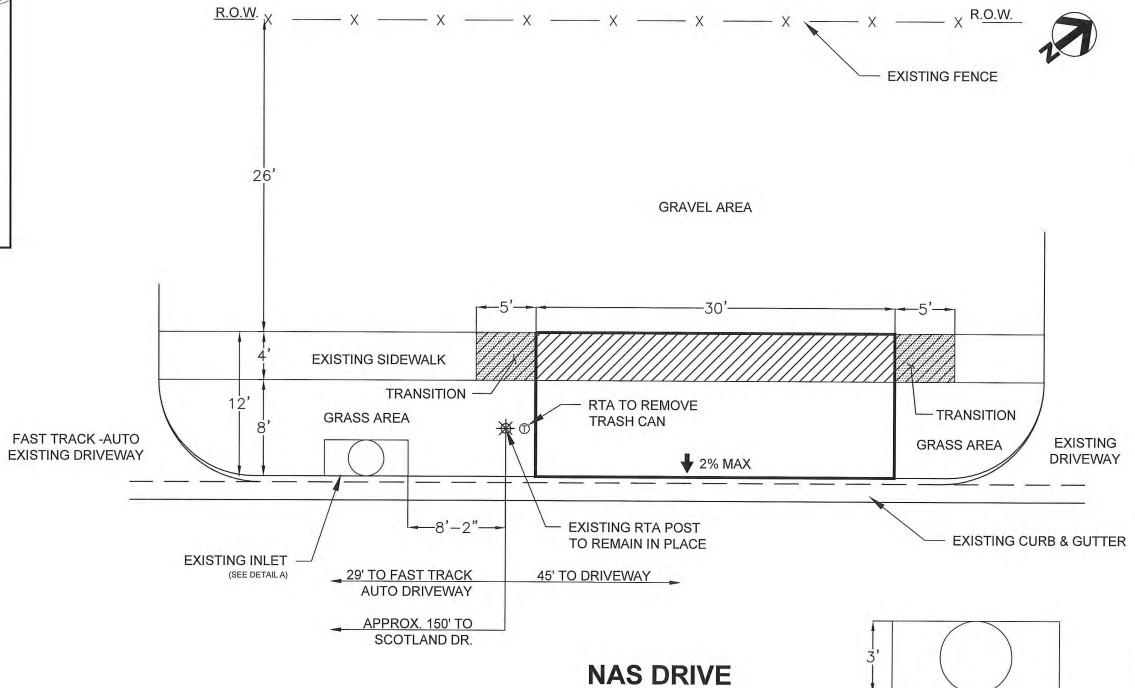

A EXISTING INLET (NOT TO SCALE)

8' 4' 0 8' 16

GRAPHIC SCALE: 1/8"= 1'-0"

REV. REVISIONS APPR. DATE



OFFICE LOCATION:

12-03-2015

4501 Gollihar Rd. Corpus Christi, Texas 78411 P.O. Box 3099 Corpus Christi, Texas 78463 (361)-814-9900 Drawn By: NV

AS SHOWN

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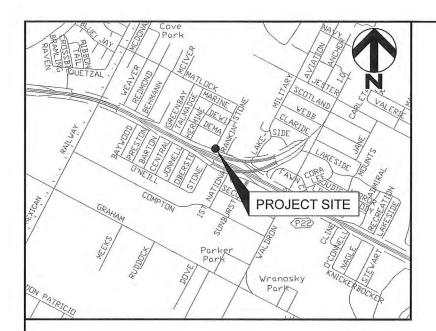
CORPUS CHRISTI REGIONAL TRANSPORTATION AUTHORITY

ADA BUS STOP IMPROVEMENTS PHASE VI OCTOBER 2015 STOP ID (606)

NAS DRIVE @ SCOTLAND-EXHIBIT C CORPUS CHRISTI, TEXAS


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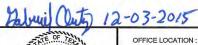
Sheet 4-C Of 21





CONCRETE SHELTER PAD	135	SF
CONCRETE BUS PAD	0,574	SF
RAMPS SECTION	- 1	SF
LANDING SECTION		SF
SIDEWALK SECTION	35	SF
CURB AND GUTTER	-	LF
SIDEWALK DRAIN CROSSING	-	SF
6" HEADER CURB	1 14	LF
PAVEMENT REPAIR	-	SF
DEMOLITION OF EXISTING CURB AND GUTTER	-	LF
DEMOLITION OF EXISTING SIDEWALK	86	SF
DEMOLITION OF EXISTING SHELTER PAD	1 -	SF
SAW CUT CONCRETE PAVEMENT	8	LF
SAW CUT ASPHALT PAVEMENT	25	LF
RELOCATE EXISTING BUS STOP SIGN		EA
TRAFFIC CONTROL PLAN ALLOWANCE	1	EA



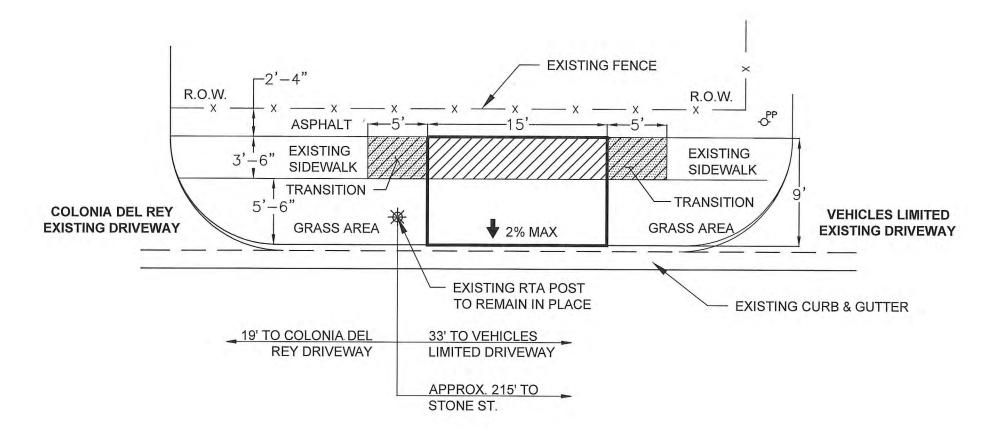

* GABRIEL J. ORTIZ

Checked By: KM 4501 Gollihar Rd. Corpus Christi, Texas 78411 P.O. Box 3099 Corpus Christi, Texas 78463 (361)-814-9900

Drawn By: NV

AS SHOWN

12-02-2015




CORPUS CHRISTI REGIONAL TRANSPORTATION AUTHORITY




ADA BUS STOP IMPROVEMENTS PHASE VI OCTOBER 2015 STOP ID (670) SOUTH PADRE ISLAND DRIVE @ STONE-EXHIBIT C CORPUS CHRISTI, TEXAS

Dwg. 9567-EXHIBIT 5-C

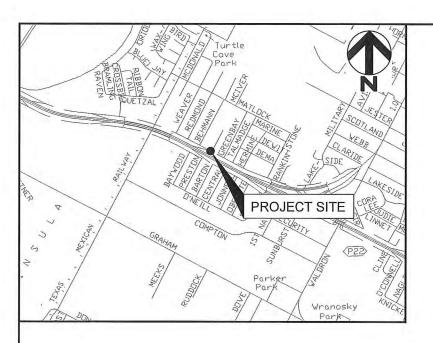

CONCRETE SHELTER PAD	114	SF
CONCRETE BUS PAD	_3 _ 2_	SF
RAMPS SECTION	-	SF
LANDING SECTION	-	SF
SIDEWALK SECTION	44	SF
CURB AND GUTTER	-1-	LF
SIDEWALK DRAIN CROSSING	- A	SF
6" HEADER CURB	19	LF
PAVEMENT REPAIR	_	SF
DEMOLITION OF EXISTING CURB AND GUTTER	_ J _ _ [LF
DEMOLITION OF EXISTING SIDEWALK	104	SF
DEMOLITION OF EXISTING SHELTER PAD	-	SF
SAW CUT CONCRETE PAVEMENT	8	LF
SAW CUT ASPHALT PAVEMENT	26	LF
RELOCATE EXISTING BUS STOP SIGN	1	EA
TRAFFIC CONTROL PLAN ALLOWANCE	1	EA



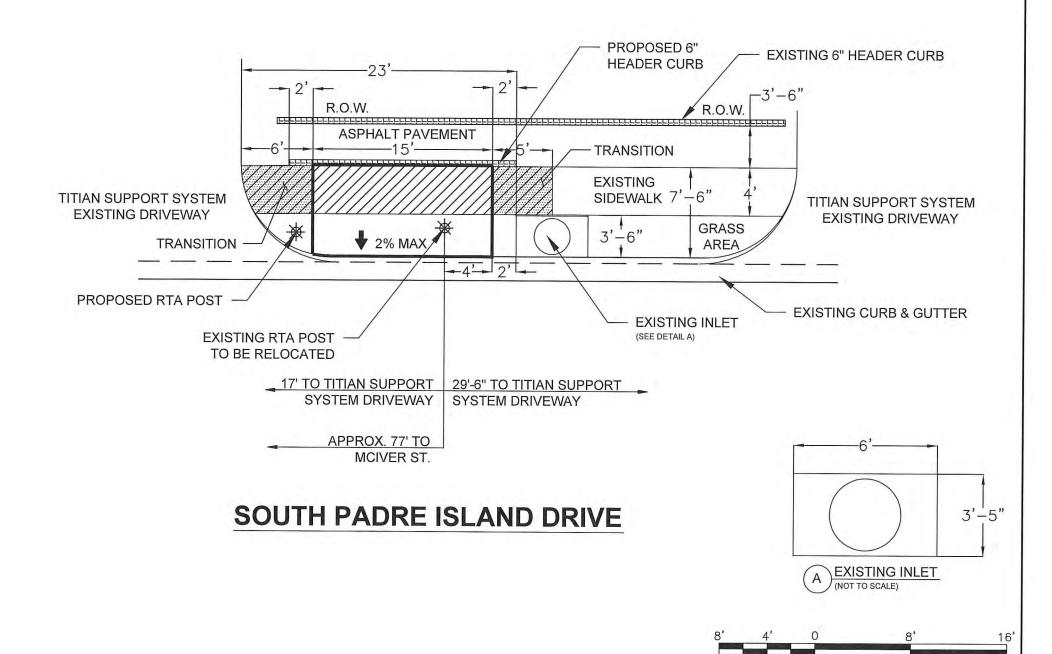

S APPR. DATE OFFICE LOCATION:

REV.	REVISIONS	APPR.	DATE	
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OFFICE LOCATION

4501 Gollihar Rd. Corpus Christi, Texas 78411 P.O. Box 3099 Corpus Christi, Texas 78463 (361)-814-9900

Draw	m By:	NV	
Chec	ked By:	KM	
Appn	oved By :	GO	
Proje	ct No. :	9567	
Scale	e:	AS SHOWN	
Date		12-02-2015	E
			T.



CORPUS CHRISTI REGIONAL TRANSPORTATION AUTHORITY


ADA BUS STOP IMPROVEMENTS
PHASE VI OCTOBER 2015
STOP ID (672)
SOUTH PADRE ISLAND DRIVE

@ MCIVER-EXHIBIT C
CORPUS CHRISTI, TEXAS

GRAPHIC SCALE: 1/8"= 1'-0"

6-C

Sheet 6-C Of 21

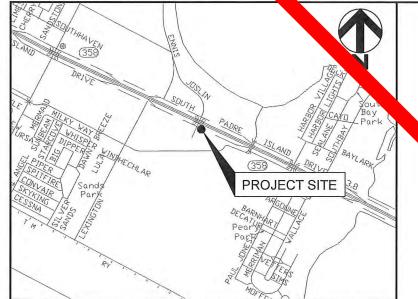

SF

SF

SF

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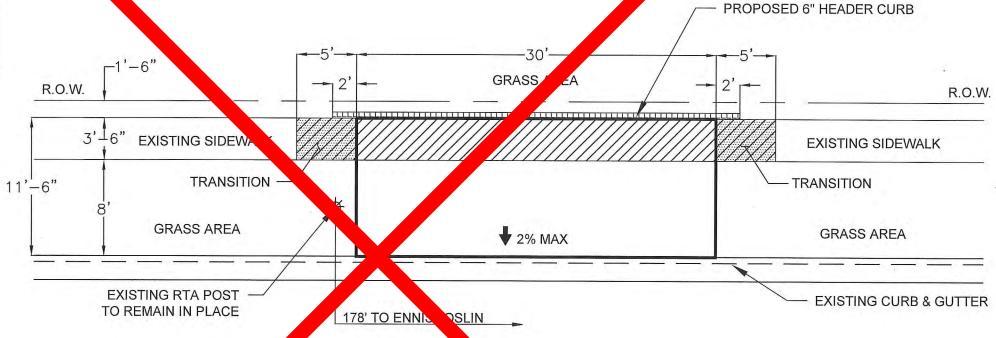
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SOUTH PADNE ISLAND DRIVE

CONCRETE SHELTER PAD

CONCRETE BUS PAD

RAMPS SECTION LANDING SECTION

CURB AND GUTTER

PAVEMENT REPAIR

SIDEWALK DRAIN CROSSING

DEMOLITION OF EXISTING CURB AND GUTTER DEMOLITION OF EXISTING SIDEWALK

DEMOLITION OF EXISTING SHELTER PAD

SAW CUT CONCRETE PAVEMENT

RELOCATE EXISTING BUS STOP SIGN

TRAFFIC CONTROL PLAN ALLOWANCE

SAW CUT ASPHALT PAVEMENT

GABRIEL J. ORTIZ 114464

Drawn By: NV Checked By: KM mihar Rd. S Christi, Texas 78411 Box 3099 Approved By: GO Corpus Christi, Texas 78463 (361)-814-9900

Naismith Engineering,Inc Tx. Registration No. F-000355

AS SHOWN

12-02-2015



CORPUS CHRISTI REGIONAL TRANSPORTATION AUTHORITY

STOP IMPROVEMENTS VI OCTOBER 2015 OP ID (694)


SOUTH RORE ISLAND DRIVE @ ENNIS SLIN-EXHIBIT C CORPUS CHRISTI, TEXAS

GRAPHIC SCALE: 1/8"= 1'-0"

Dwg. 9567-EXHIBIT


7-C

Sheet 7-C Of 21

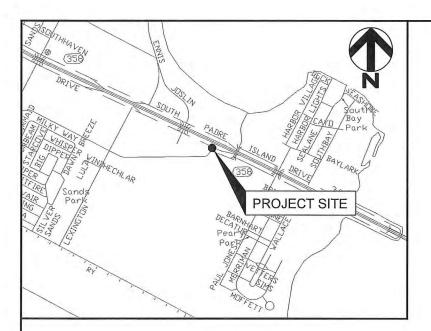



CONCRETE SHELTER PAD	245	SF
CONCRETE BUS PAD	-	SF
RAMPS SECTION	-	SF
LANDING SECTION	. 	SF
SIDEWALK SECTION	40	SF
CURB AND GUTTER	Siles III	LF
SIDEWALK DRAIN CROSSING	1 (SF
6" HEADER CURB		LF
PAVEMENT REPAIR	_	SF
DEMOLITION OF EXISTING CURB AND GUTTER		LF
DEMOLITION OF EXISTING SIDEWALK	160	SF
DEMOLITION OF EXISTING SHELTER PAD	-	SF
SAW CUT CONCRETE PAVEMENT	8	ĹF
SAW CUT ASPHALT PAVEMENT	-5-	LF
RELOCATE EXISTING BUS STOP SIGN	-	EA
TRAFFIC CONTROL PLAN ALLOWANCE	1	LS

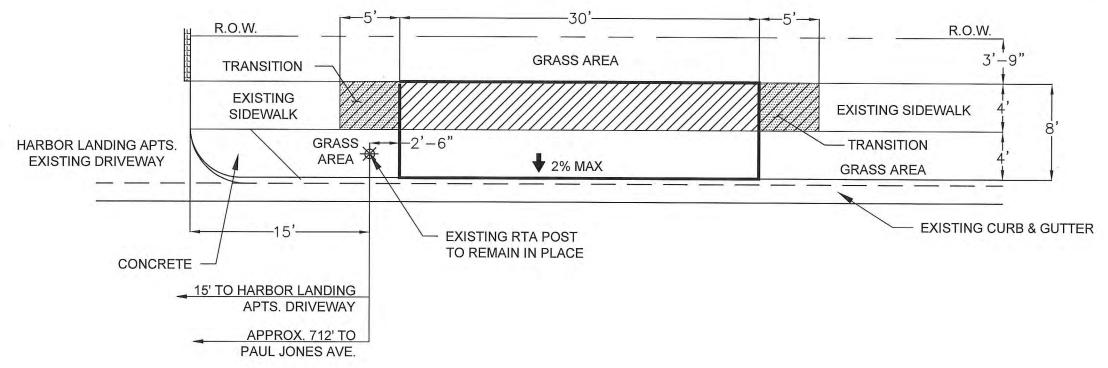



-	

2-03-2015 OFFICE LOCATION:

4501 Gollihar Rd. Corpus Christi, Texas 78411 P.O. Box 3099 Corpus Christi, Texas 78463 (361)-814-9900

Drawn By:	NV	
Checked By:	KM	
Approved By:	GO	
Project No. :	9567	
Scale:	AS SHOWN	Nais
Date:	12-02-2015	Engine
		Tv Dogletmi



CORPUS CHRISTI REGIONAL TRANSPORTATION AUTHORITY


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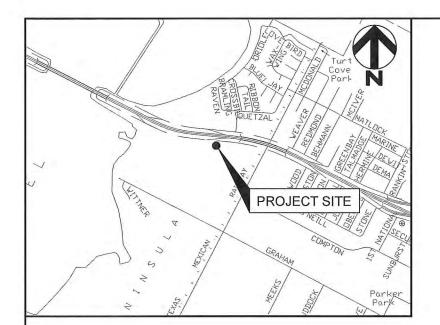
8033 SOUTH PADRE ISLAND DRIVE @ HARBOR LANDING APTS.-EXHIBIT C CORPUS CHRISTI, TEXAS

8-C

Sheet 8-C Of 21

Dwg. 9567-EXHIBIT




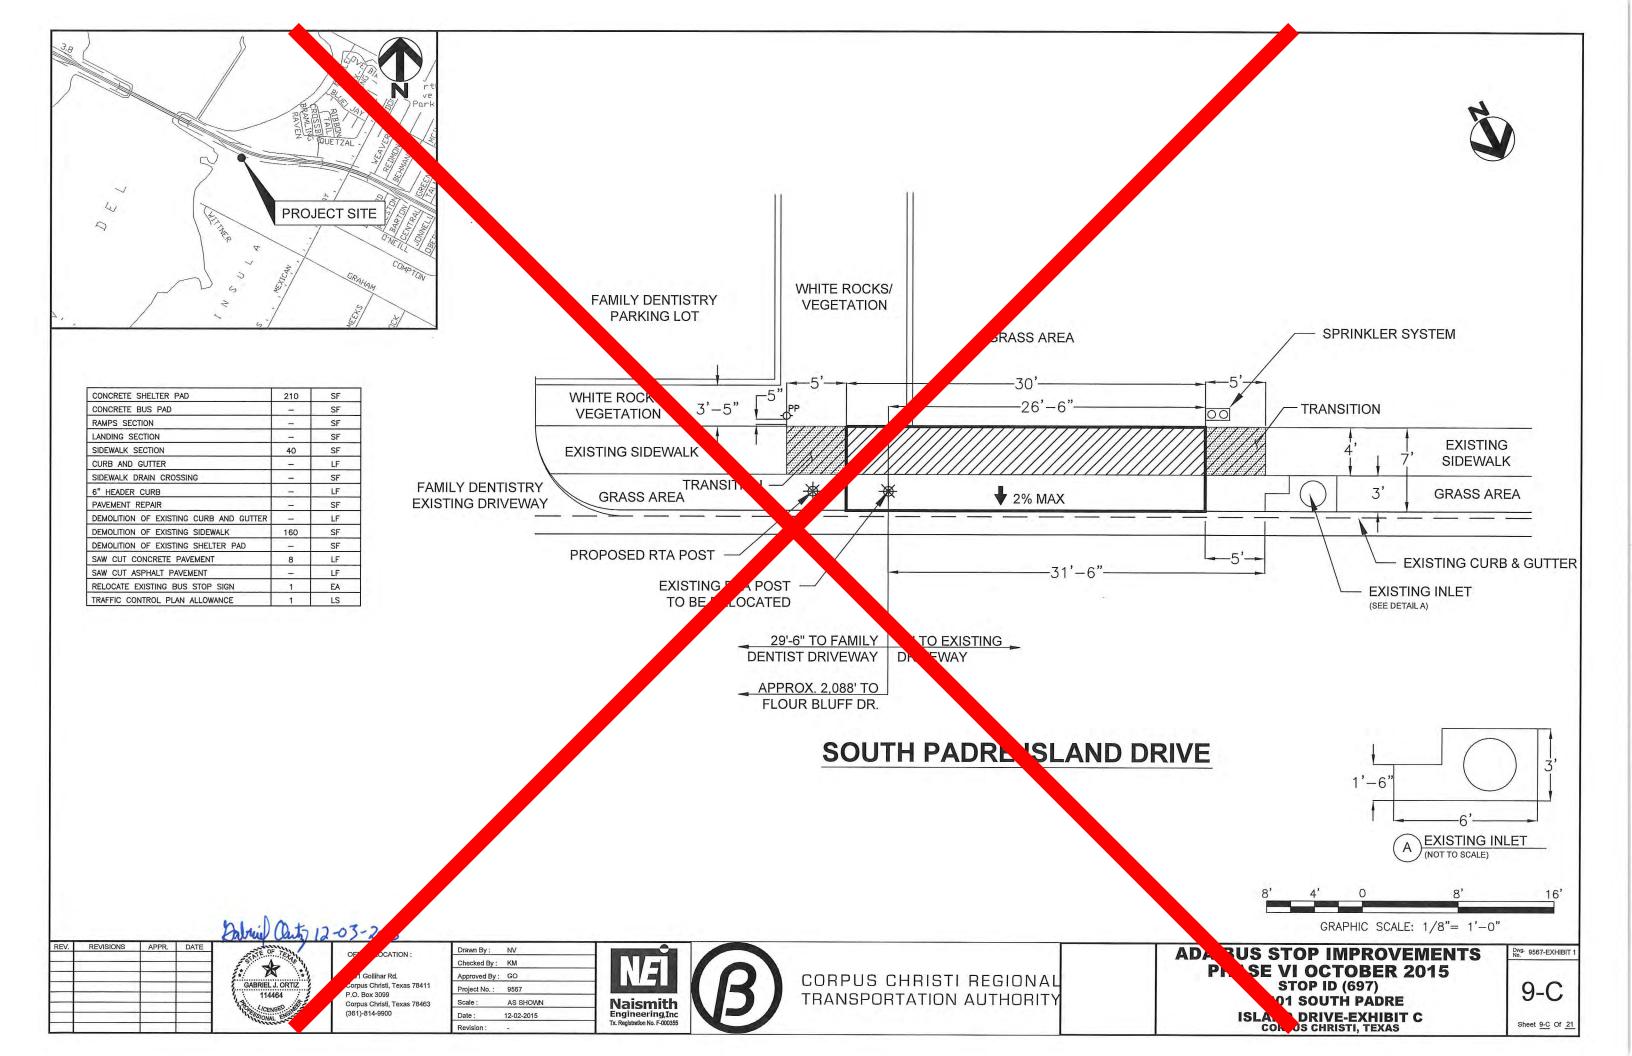




PADRE MOTEL PARKING LOT

R.O.W. R.O.W.

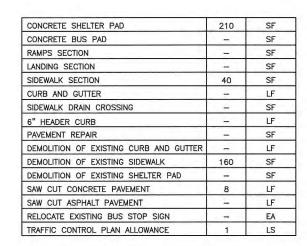

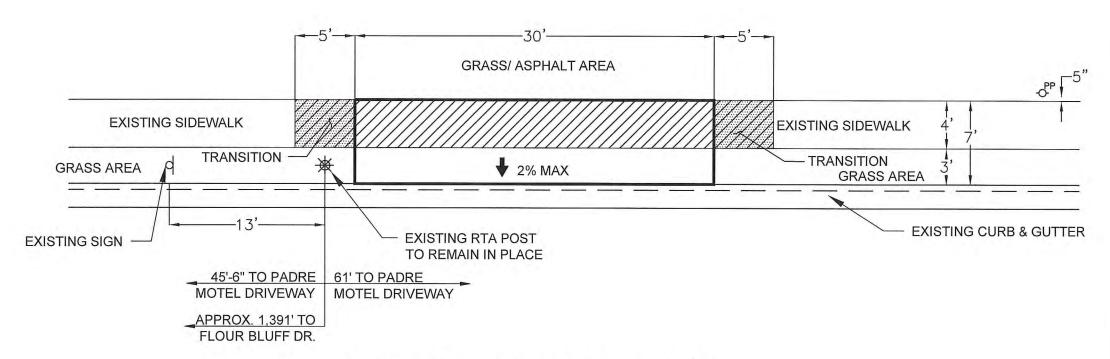

SOUTH PADRE ISLAND DRIVE



REV.	REVISIONS	APPR.	DATE
1			

Mail Outo 12-03-2015 * GABRIEL J. ORTIZ

4501 Gollihar Rd. Corpus Christi, Texas 78411 Corpus Christi, Texas 78463 (361)-814-9900

֡	Drawn By:	NV	
	Checked By:	KM	
	Approved By:	GO	
	Project No. :	9567	
	Scale :	AS SHOWN	
	Date:	12-02-2015	




CORPUS CHRISTI REGIONAL TRANSPORTATION AUTHORITY


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Dwg. 9567-EXHIBIT

10-C

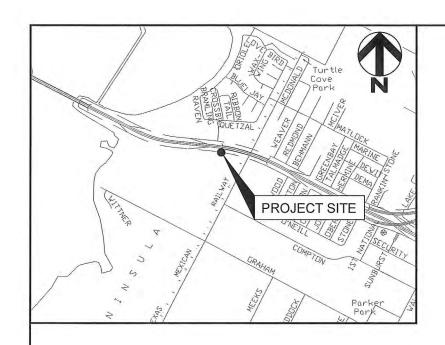

CONCRETE SHELTER PAD	428	SF
CONCRETE BUS PAD	-	SF
RAMPS SECTION	_	SF
LANDING SECTION	-	SF
SIDEWALK SECTION	50	SF
CURB AND GUTTER	-	LF
SIDEWALK DRAIN CROSSING		SF
6" HEADER CURB	-	LF
PAVEMENT REPAIR	-	SF
DEMOLITION OF EXISTING CURB AND GUTTER	-	LF
DEMOLITION OF EXISTING SIDEWALK	170	SF
DEMOLITION OF EXISTING SHELTER PAD	-	SF
SAW CUT CONCRETE PAVEMENT	- 10	LF
SAW CUT ASPHALT PAVEMENT	-	LF
RELOCATE EXISTING BUS STOP SIGN	-	EA
DEMOLITION OF FOUNDATION	3	EA
TRAFFIC CONTROL PLAN ALLOWANCE	1	LS




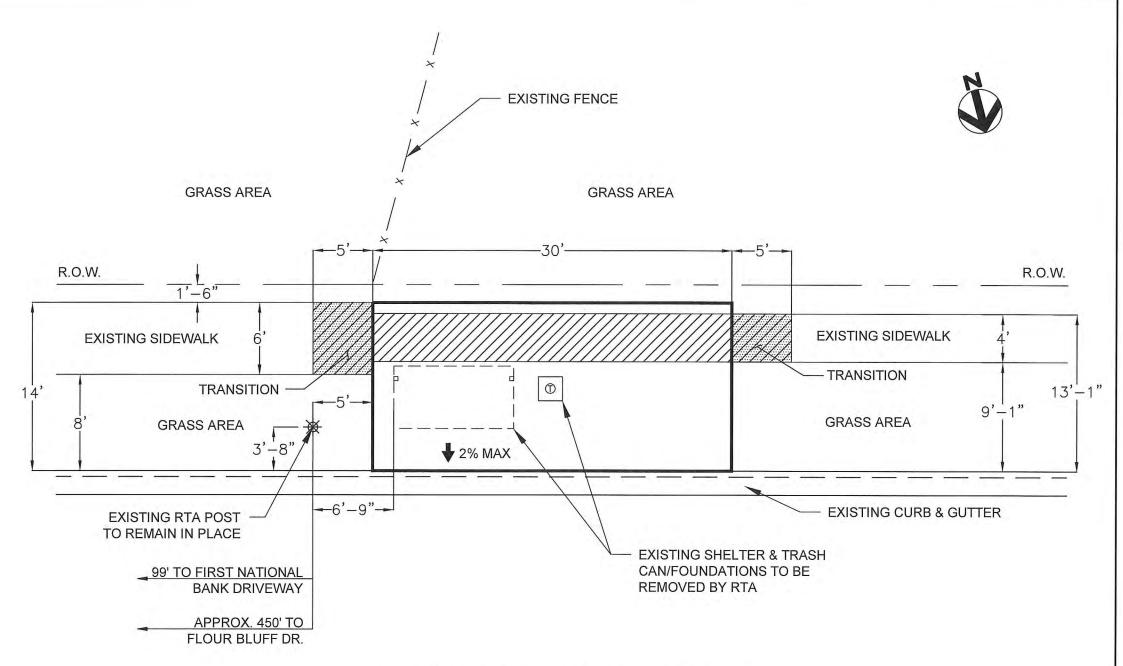

Dalrie at 12-03-2015 GABRIEL J. ORTIZ

Corpus Christi, Texas 78411 P.O. Box 3099 Corpus Christi, Texas 78463 (361)-814-9900


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AS SHOWN	
12-02-2015	
	KM GO 9567 AS SHOWN

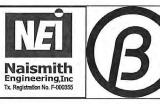

CORPUS CHRISTI REGIONAL TRANSPORTATION AUTHORITY


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SOUTH PADRE ISLAND DRIVE @ FLOUR BLUFF DRIVE NS WALMART-EXHIBIT C CORPUS CHRISTI, TEXAS Dwg. 9567-EXHIBIT 1 11-C Sheet 11-C Of 21



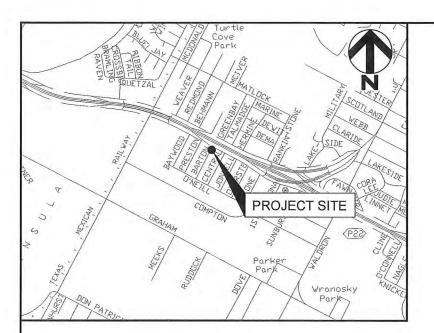

CONCRETE SHELTER PAD	240	SF
CONCRETE BUS PAD	-	SF
RAMPS SECTION	_ <u>=</u>	SF
LANDING SECTION	-	SF
SIDEWALK SECTION	40	SF
CURB AND GUTTER	= = .	LF
SIDEWALK DRAIN CROSSING	-	SF
6" HEADER CURB	32	LF
PAVEMENT REPAIR	A 200	SF
DEMOLITION OF EXISTING CURB AND GUTTER	-	LF
DEMOLITION OF EXISTING SIDEWALK	160	SF
DEMOLITION OF EXISTING SHELTER PAD	- F	SF
SAW CUT CONCRETE PAVEMENT	8	LF
SAW CUT ASPHALT PAVEMENT		LF
RELOCATE EXISTING BUS STOP SIGN	1	EA
TRAFFIC CONTROL PLAN ALLOWANCE	1	LS



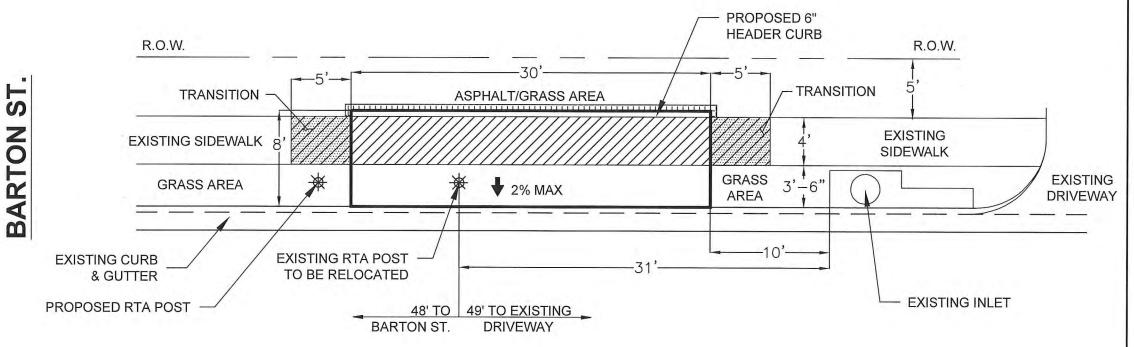

REV. REVISIONS APPR. DATE



OFFICE LOCATION

4501 Gollihar Rd. Corpus Christi, Texas 78411 P.O. Box 3099 Corpus Christi, Texas 78463 (361)-814-9900

Drawn By:	NV	
Checked By:	KM	
Approved By:	GO	
Project No. :	9567	
Scale :	AS SHOWN	
Date:	12-02-2015	




CORPUS CHRISTI REGIONAL TRANSPORTATION AUTHORITY

ADA BUS STOP IMPROVEMENTS
PHASE VI OCTOBER 2015
STOP ID (702)
SOUTH PADRE ISLAND DRIVE
@ BARTON-EXHIBIT C
CORPUS CHRISTI, TEXAS


Dwg. 9567-EXHIBIT

Sheet 12-C Of 21

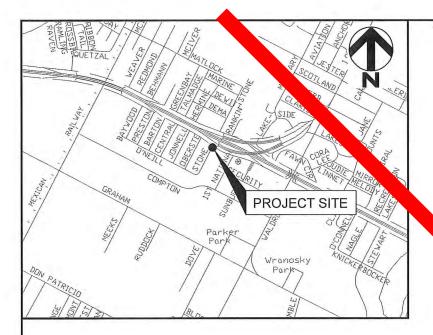



CONCRETE SHELTER PAD	240	SF
CONCRETE BUS PAD		SF
RAMPS SECTION	4.5	SF
LANDING SECTION		SF
SIDEWALK SECTION	40	SF
CURB AND GUTTER	320	LF
SIDEWALK DRAIN CROSSING		SF
6" HEADER CURB	- 1 - 1 T	LF
PAVEMENT REPAIR	_	SF
DEMOLITION OF EXISTING CURB AND GUTTER	-	LF
DEMOLITION OF EXISTING SIDEWALK	160	SF
DEMOLITION OF EXISTING SHELTER PAD	-	SF
SAW CUT CONCRETE PAVEMENT	8	LF
SAW CUT ASPHALT PAVEMENT	-	LF
RELOCATE EXISTING BUS STOP SIGN	5401	EA
TRAFFIC CONTROL PLAN ALLOWANCE	1	LS

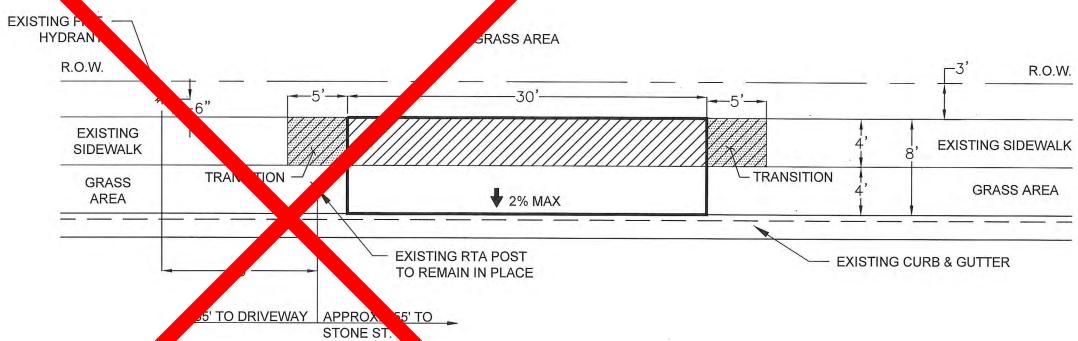

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REV. REVISIONS APPR. DATE

GABRIEL GABRIEL

OFFICE LOCATION:

4501 Gollihar Rd. Corpus Christi, Texas 78411 P.O. Box 3099 Corpus Christi, Texas 78463 (361)-814-9900 Nai Engir Tx Role

Checked By: KM

AS SHOWN

12-02-2015



CORPUS CHRISTI REGIONAL TRANSPORTATION AUTHORITY

8'	4'	0	8'	
	GRA	APHIC SC	ALE: 1/8"= 1'-0	**

PA BUS STOP IMPROVEMENTS
PHASE VI OCTOBER 2015
STOP ID (704)
OUTH PADRE ISLAND DRIVE

@ STONE-EXHIBIT C
CORPUS CHRISTI, TEXAS

Dwg. 9567-EXHIBIT

13-C

Sheet 13-C Of 2



270

40

SF SF

SF

SF SF

LF

SF

SF

LF SF SF LF

LF

EA

CONCRETE SHELTER PAD

CONCRETE BUS PAD
RAMPS SECTION

LANDING SECTION

SIDEWALK SECTION

CURB AND GUTTER

6" HEADER CURB


SIDEWALK DRAIN CROSSING

SAW CUT ASPHALT PAVEMENT

RELOCATE EXISTING BUS STOP SIGN

TRAFFIC CONTROL PLAN ALLOWANCE



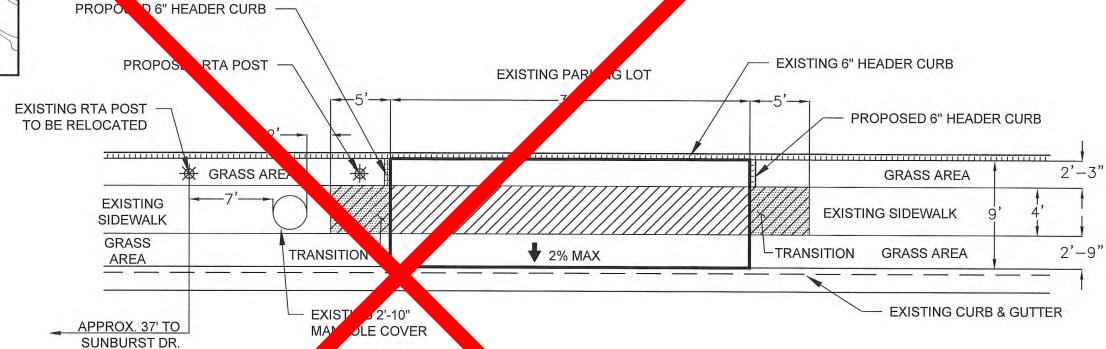

SOUTH PALRE ISLAND DRIVE

REV. REVISIONS APPR. DATE OF TO STREET OF THE OF TH

GABRIEL J. ORTIZ
114464

OFFICE LC N:

4501 ar Rd.
C whristl, Texas 78411
Box 3099
Jopus Christl, Texas 78463
(361)-814-9900

 Drawn By :
 NV

 Checked By :
 KM

 Approved By :
 GO

 Project No :
 9567

 Scale :
 AS SHOWN

 Date :
 12-02-2015






ADA BUS STOP IMPROVEMENTS
PHAS VI OCTOBER 2015
TOP ID (705)
SOUTH DRE ISLAND DRIVE @

SOUTH DRE ISLAND DRIVE (SUNB ST-EXHIBIT C CORPUS ARISTI, TEXAS

GRAPHIC SCALE: 1/8"= 1'-0"


Dwg. 9567-EXHIBIT 1

Sheet 14-C Of 21

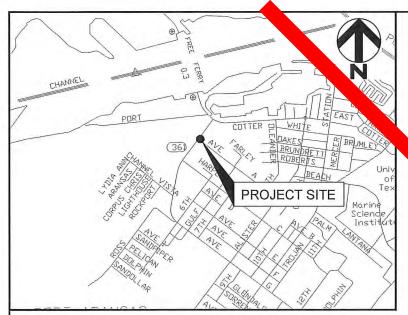




CONCRETE SHELTER PAD	240	SF
CONCRETE BUS PAD	- 4	SF
RAMPS SECTION	11-0.10	SF
LANDING SECTION	1 i -4	SF
SIDEWALK SECTION	50	SF
CURB AND GUTTER	-	LF
SIDEWALK DRAIN CROSSING	-	SF
6" HEADER CURB	-	LF
PAVEMENT REPAIR	-	SF
DEMOLITION OF EXISTING CURB AND GUTTER	37-C	LF
DEMOLITION OF EXISTING SIDEWALK	200	SF
DEMOLITION OF EXISTING SHELTER PAD	-	SF
SAW CUT CONCRETE PAVEMENT	10	LF
SAW CUT ASPHALT PAVEMENT	-	LF
RELOCATE EXISTING BUS STOP SIGN		EA
12" HEADER CURB	36	LF
TRAFFIC CONTROL PLAN ALLOWANCE	1	LS

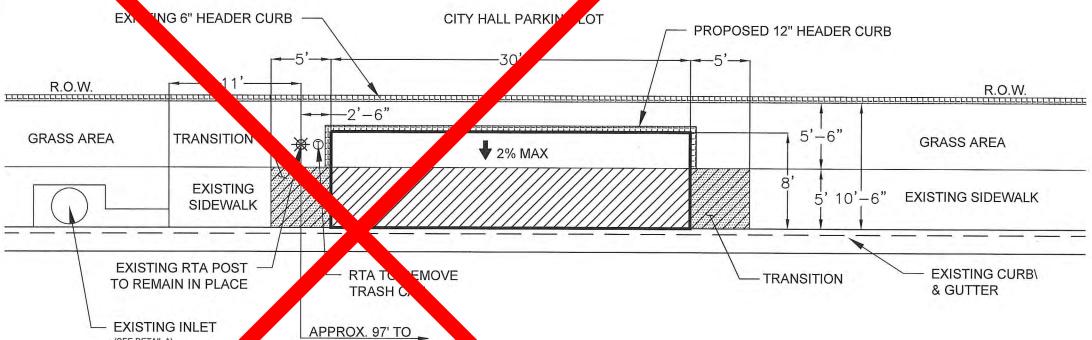

CUT - FF RD.

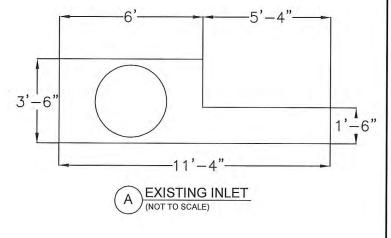

8' 4' 0 8' 16 GRAPHIC SCALE: 1/8"= 1'-0"

REV.	REVISIONS	APPR.	DATE
		-	

GABRIEL J. ORTIZ
114464

J. CENSER

OFFIC

Gollihar Rd.
Apus Christi, Texas 78411
P.O. Box 3099
Corpus Christi, Texas 78463
(361)-814-9900

| Drawn By : NV | Checked By : KM | Approved By : GO | Project No. : 9567 | Scale : AS SHOWN | Date : 12-02-2015 | Engineering,Inc Tx. Registration No. F-000355 | Registr

(SEE DETAIL A)



W AVENUE A


CORPUS CHRISTI REGIONAL TRANSPORTATION AUTHORITY

ADA LAS STOP IMPROVEMENTS
PHACE VI OCTOBER 2015
STOP ID (1415)
CUT OFF ROAD @ AVE. A
CITY ALL-EXHIBIT C
CORPUS CHRISTI, TEXAS


Dwg. 9567-EXHIBIT

15-C

Sheet 15-C Of 21

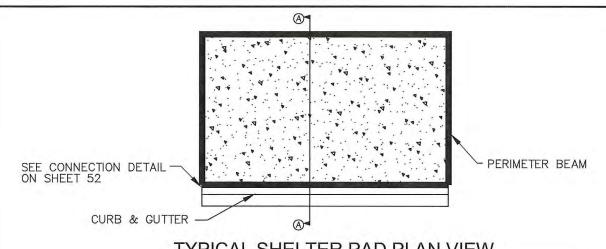


TYPICAL SHELTER PAD PLAN VIEW

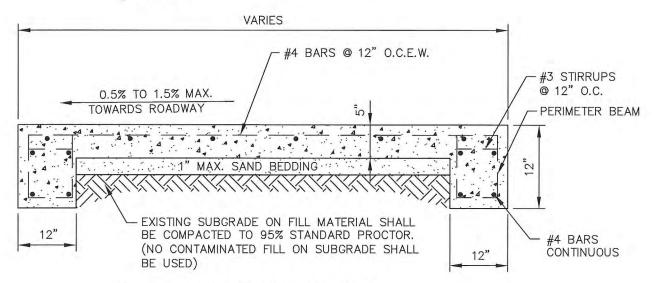

SHELTER PAD SECTION A-A

SCALE: N.T.S.

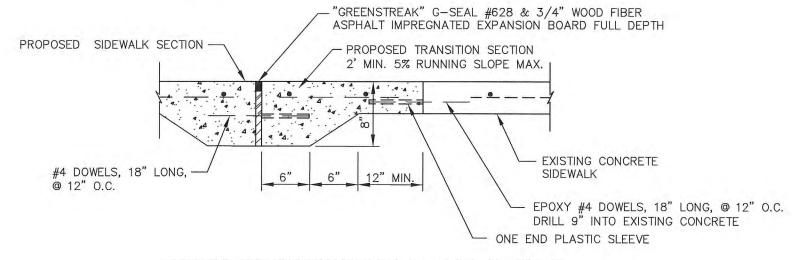

CONCRETE SIDEWALK TRANSITION DETAIL

12-03-20/5 REVISIONS APPR. DATE OFFICE LOCATION : * 4501 Gollihar Rd. Corpus Christi, Texas 78411 P.O. Box 3099 Corpus Christi, Texas 78463 (361)-814-9900

Drawn By: NV Checked By: KM Approved By: GO Project No.: 9567 AS SHOWN Scale: 12-02-2015




CORPUS CHRISTI REGIONAL TRANSPORTATION AUTHORITY

#4 BARS @ 12" O.C.E.W. SHALL BE USED IN PLACE OF CITY STANDARD #4 DOWELS, 18" LONG, @ 12" O.C. ONE END COVERED WITH A PLASTIC SLEEVE TYPICAL CONCRETE SIDEWALK PLAN VIEW SCALE: N.T.S. MATCH EXISTING (AS SHOWN IN THE PLANS) #4 BARS @ 12" O.C.E.W. SHALL BE USED IN PLACE OF CITY STANDARD 2% MAX. 4 4 4 4 4 4 2" MAX. SAND CUSHION THICKEN CONCRETE (TYP.) CONCRETE SIDEWALK SECTION A-A SCALE: N.T.S. "GREENSTREAK" G-SEAL #628 & 3/4" WOOD FIBER ASPHALT IMPREGNATED EXPANSION BOARD FULL DEPTH MAX: SAND CUSHION 2" MAX. SAND CUSHION

EXPANSION JOINT

@ 40' O.C. MAX. OR AS INDICATED

A 1

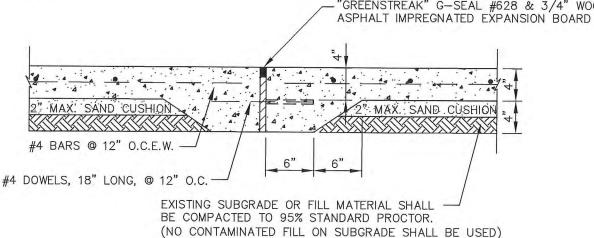

CONCRETE SIDEWALK AND EXPANSION JOINT DETAIL SECTION B-B

SCALE: N.T.S.

ADA BUS STOP IMPROVEMENTS
PHASE VI OCTOBER 2015


MISCELLANEOUS DETAILS - 1


18

Dwg. 9567-EXHIBIT

REGIONAL TRANSPORTATION AUTHORITY CORPUS CHRISTI, TEXAS

Sheet 18 Of 21

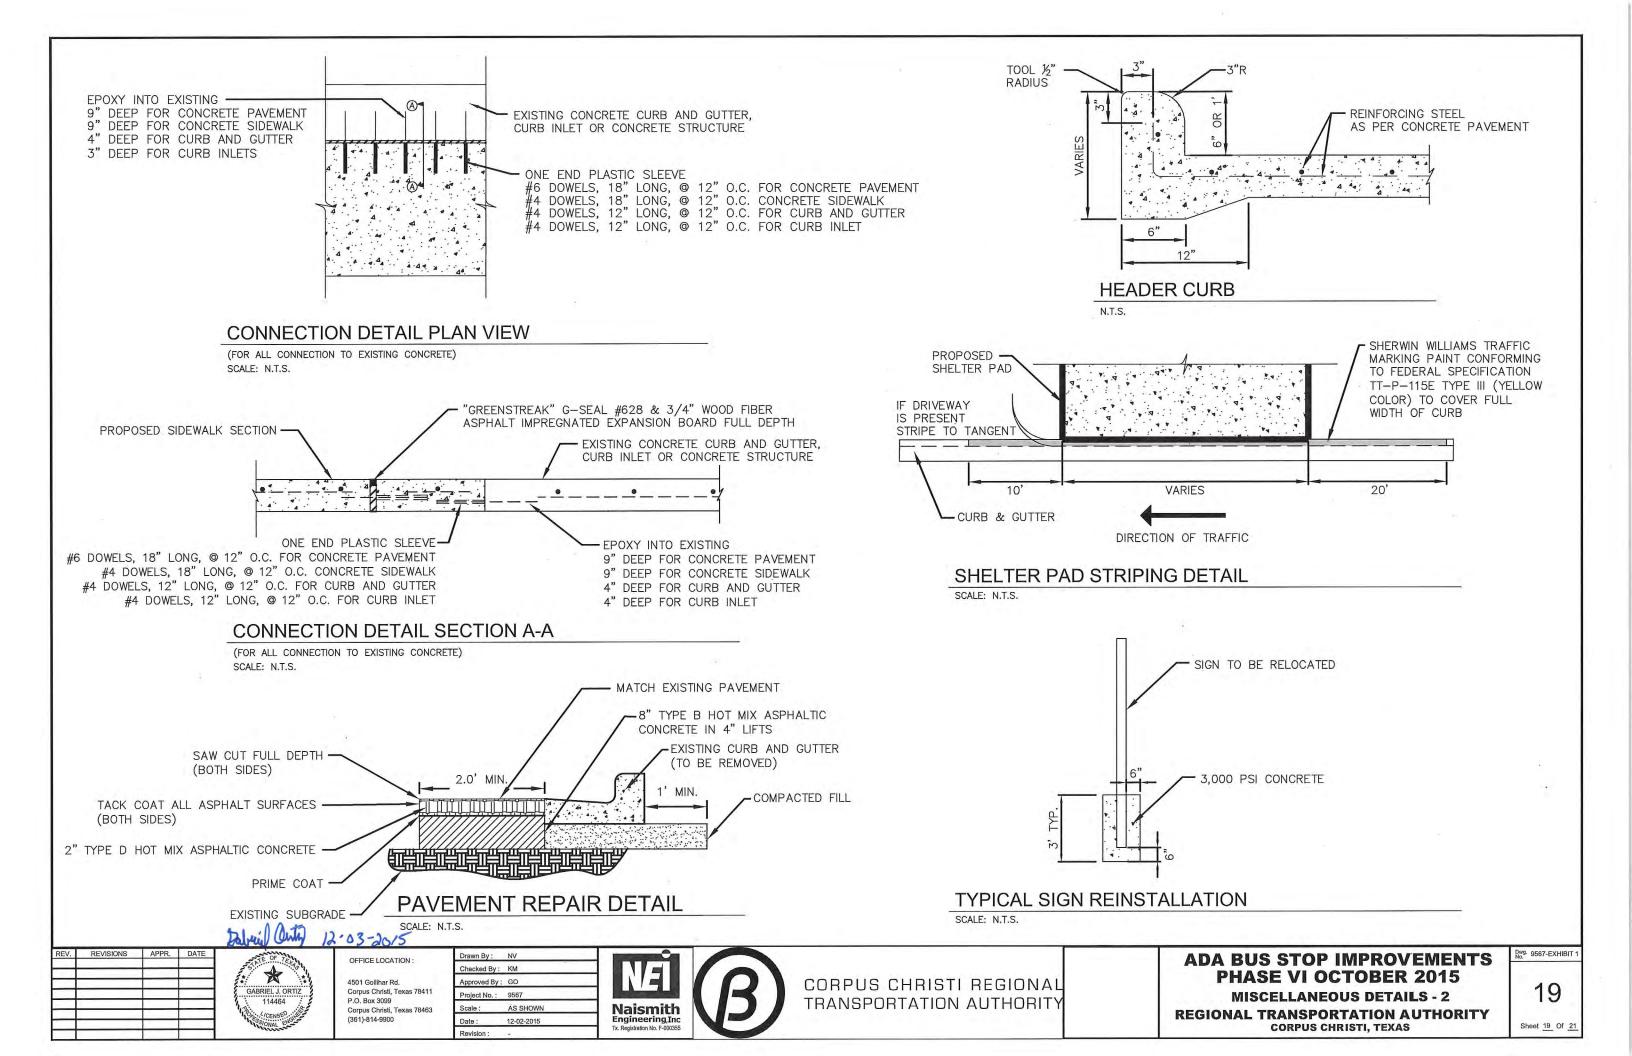

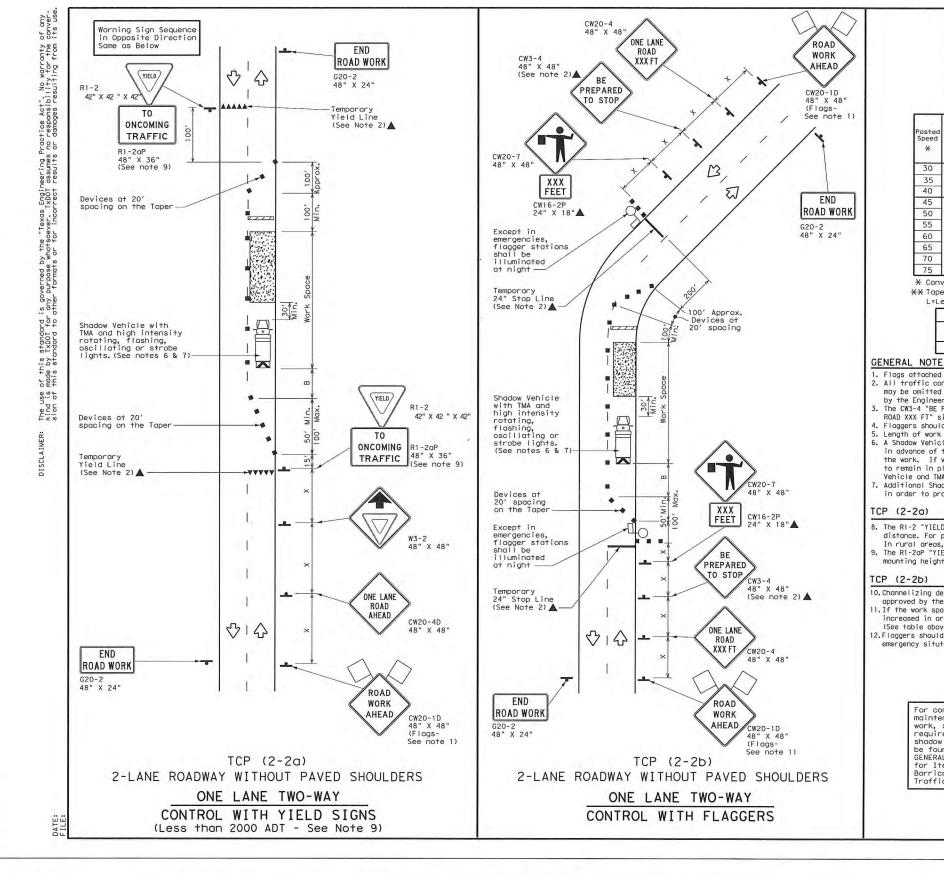

	LEGE	ND	
erro	Type 3 Barricade	88	Channelizing Devices
	Heavy Work Vehicle		Truck Mounted Attenuator (TMA)
	Trailer Mounted Flashing Arrow Board	M	Portable Changeable Message Sign (PCMS)
-	Sign	4	Traffic Flow
A	Flag	ПО	Flagger

Posted Speed *	Formula	Minimum Desirable Taper Lengths **		Suggested Maximum Spacing of Channelizing Devices		Minimum Sign Spacing "X"	Suggested Longitudinal Buffer Space	Stopping Sight Distance	
		10' Offset	11' Offset	12' Offset	On a Taper	On a Tangent	Distance	"B"	
30	2	150'	165'	180'	30'	60'	120'	90'	200'
35	$L = \frac{WS^2}{60}$	205'	225'	245'	35′	70'	160'	120'	250'
40		265'	295'	320'	40'	80'	240'	155'	305'
45		450'	495'	540'	45'	90'	320'	195'	360'
50		500'	550'	600'	50'	100'	400'	240'	425'
55	L=WS	550'	605'	660'	55'	110'	500'	295'	495'
60		600'	660'	720'	60'	120'	600'	350′	570'
65		650'	715'	780'	65′	130'	700'	410'	645'
70		700'	770'	840'	70'	140'	800'	475'	730'
75		750'	825'	900'	75'	150'	900'	540'	820'

* Conventional Roads Only

** Taper lengths have been rounded off.

L=Length of Taper (FT) W=Width of Offset (FT) S=Posted Speed (MPH)

		TYPICAL L	JSAGE	
MOBILE	SHORT DURATION	SHORT TERM STATIONARY	INTERMEDIATE TERM STATIONARY	LONG TERM STATIONARY
	1	1	1	

- 1. Flags attached to signs where shown, are REQUIRED.
- All traffic control devices illustrated are REQUIRED, except those denoted with the triangle symbol
 may be omitted when stated elsewhere in the plans, or for routine maintenance work, when approved by the Engineer.

- 3. The CW3-4 "BE PREPARED TO STOP" sign may be installed after the CW20-4 "ONE LANE ROAD XXX FT" sign, but proper sign spacing shall be maintained.

 4. Flaggers should use two-way radios or other methods of communication to control traffic.

 5. Length of work space should be based on the ability of flaggers to communicate.
- 6. A Shadow Vehicle with a TMA should be used anytime it can be positioned 30 to 100 feet in advance of the area of crew exposure without adversely affecting the performance or quality of the work. If workers are no longer present but road or work conditions require the traffic control to remain in place, Type 3 Barricades or other channelizing devices may be substituted for the Shadow Vehicle and TMA.
- Additional Shadow Vehicles with TMAs may be positioned off the paved surface, next to those shown in order to protect a wider work space.
- The R1-2 "YIELD" sign traffic control may be used on projects with approaches that have adequate sight distance. For projects in urban areas, work space should be no longer than one half city black. In rural areas, roadways with less than 2000 ADT, work space should be no longer than 400 feet.
- The RI-2aP "YIELD TO ONCOMING TRAFFIC" sign shall be placed on a support at a 7 foot minimum mounting height.
- 10.Channelizing devices on the center line may be omitted when a pilot car is leading traffic and
- approved by the Engineer.

 11. If the work space is located near a horizontal or vertical curve, the buffer distances should be increased in order to maintain stopping sight distance to the flagger and a queue of stopped vehicles.
- 12.Flaggers should use 24" STOP/SLOW paddles to control traffic. Flags should be limited to emergency situtations.

For construction or maintenance contract work, specific project requirements for shadow vehicles can be found in the project GENERAL NOTES for Item 502, Barricades, Signs and Traffic Handling



Texas Department of Transportation Traffic Operations Division

TRAFFIC CONTROL PLAN ONE-LANE TWO-WAY TRAFFIC CONTROL

TCP (2-2)-12

	©1	xDOT December 1985	DN: TX	DOT	CK: TXDOT	DW: TXDOT	CK: TXDOT
		REVISIONS 2-12	CONT	SECT	JOB	-	IGHWAY
	1-97 4-98		DIST		COUNTY		SHEET NO.
_	3-03						
	162						

REV. REVISIONS APPR. DATE

OFFICE LOCATION

4501 Gollihar Rd. Corpus Christi, Texas 78411 P.O. Box 3099 Corpus Christi, Texas 78463 (361)-814-9900

Date:

Drawn By: NV Checked By: KM Approved By: GO Project No.: 9567 AS SHOWN 12-02-2015




CORPUS CHRISTI REGIONAL TRANSPORTATION AUTHORITY **ADA BUS STOP IMPROVEMENTS PHASE VI OCTOBER 2015 TRAFFIC CONTROL PLAN (2-2)-12**

REGIONAL TRANSPORTATION AUTHORITY CORPUS CHRISTI, TEXAS

Dwg. 9567-EXHIBIT

Sheet 20 Of 21

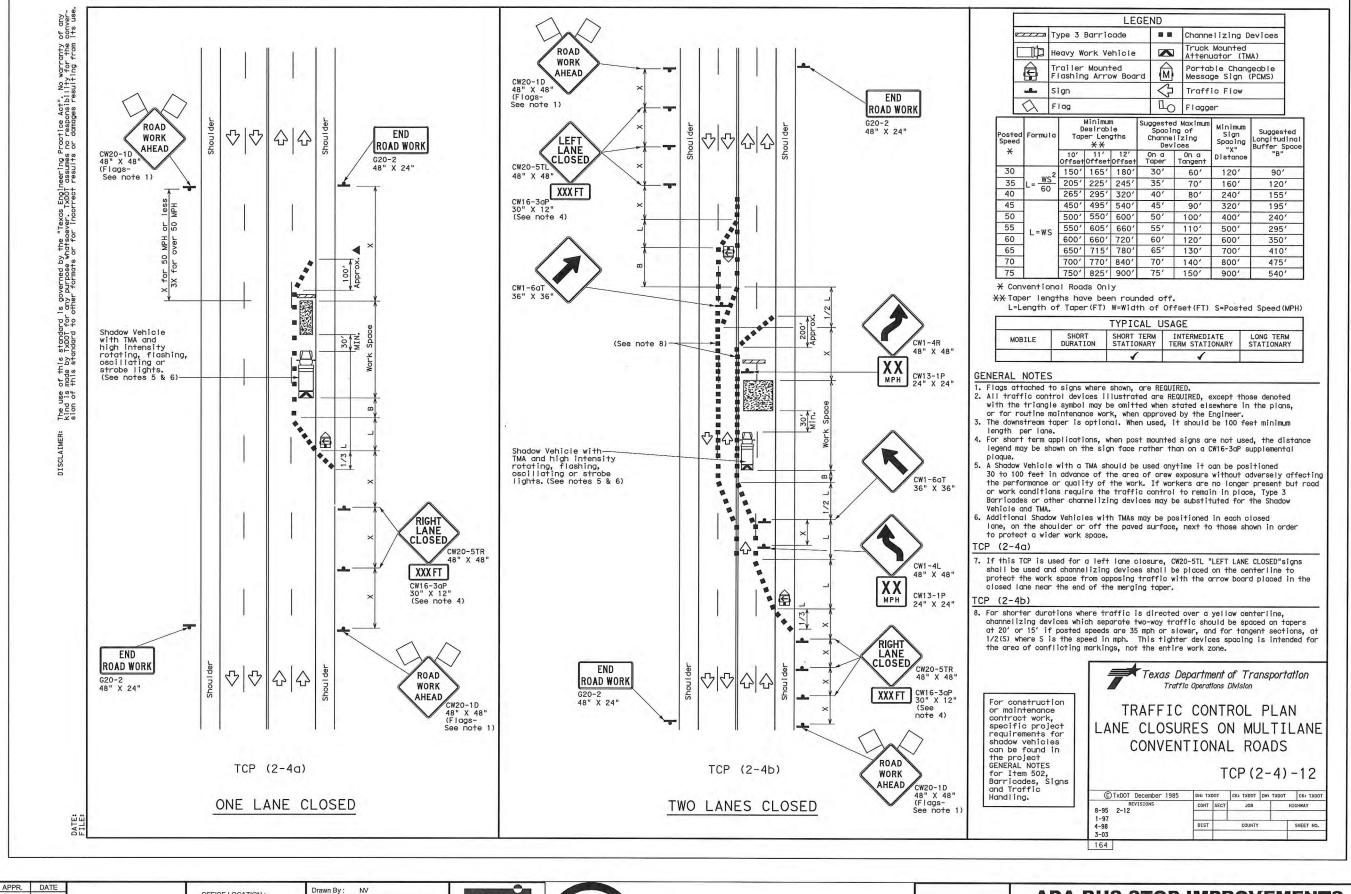

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-		1	

OFFICE LOCATION:

4501 Gollihar Rd Corpus Christi, Texas 78411 P.O. Box 3099 Corpus Christi, Texas 78463 (361)-814-9900

Checked By: KM Approved By: GO Project No.: 9567 AS SHOWN 12-02-2015

Scale:



CORPUS CHRISTI REGIONAL TRANSPORTATION AUTHORITY **ADA BUS STOP IMPROVEMENTS PHASE VI OCTOBER 2015**

TRAFFIC CONTROL PLAN (2-4)-12 REGIONAL TRANSPORTATION AUTHORITY

CORPUS CHRISTI, TEXAS

owg. 9567-EXHIBIT

Sheet 21 Of 21